


L36 54.29' S4' 41' 51"W

L18 | 113.95" | S16" 18" 19"W

L55 19.98' S77' 14' 47"E

L56 31.00' S12' 45' 13"W

DIRT ROAD

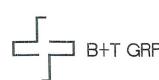

SITE NAME: NM4 LAMY

SITE ADDRESS: 99 ASTRAL VALLEY ROAD LAMY, NM 87540

	SUBMITTALS				
١٥.	BY	DATE	SUBMITTAL		
1	MG	08/23/18	FINAL SUBMITTAL		






24654 N. LAKE PLEASANT PKWY #103-163 PEORIA, AZ 85383 P. 480-440-1748 F. 623-777-1782 www.terromorksurveying.com

SITE SURVEY

JOB NO:	FIELD BY:	DRAWN BY:
1502014	MG	MG

SHEET NO: SHEET NAME
2 OF 3 IS-2

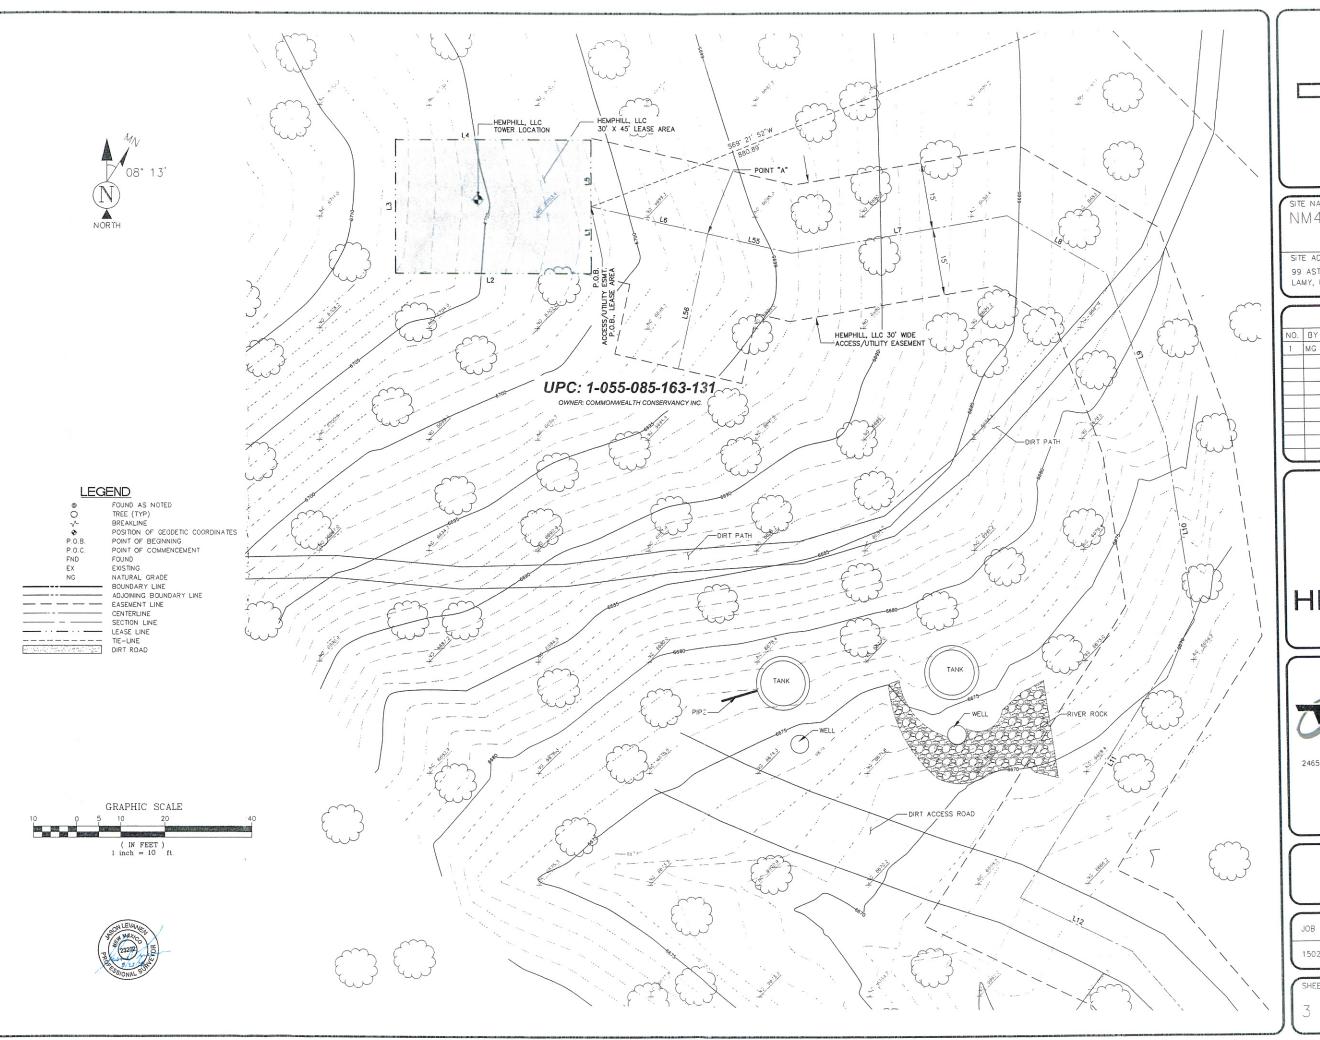



SITE NAME: NM4 LAMY

SITE ADDRESS:

99 ASTRAL VALLEY ROAD LAMY, NM 87540

	SUBMITTALS				
NO.	BY	DATE	SUBMITTAL		
1	MG	08/23/18	FINAL SUBMITTAL		
			1		
	1				





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SITE SURVEY

JOB NO:	FIELD BY:	DRAWN B
1502014	MG	MG

SHEET NO. NEA ZO SHEET NAME

3 OF 3 LS-3

KEYED NOTES:

- 1. INSTALL 4790 LF± UNDERGROUND TELCO IN (1) 4" SCH. 40 PVC CONDUIT. INSTALL IN ACCORDANCE WITH OSHA AND ALL APPLICABLE CODES.
- 2. INSTALL 4790 LF± UNDERGROUND ELEC IN (1) 4" SCH. 40 PVC CONDUIT. INSTALL IN ACCORDANCE WITH OSHA AND ALL APPLICABLE CODES.
- 3. CONSTRUCT 280 LF± 12' WIDE ACCESS ROAD AND TURNAROUND.

NOTES:

- 1. SEE LEGEND, SITE DATA, AND GENERAL NOTES ON SHEETS GN-1 -
- 2. TOWER LATITUDE, LONGITUDE & ELEVATION MEET FAA"1-A" ACCURACY REQUIREMENTS.
- 3. PROPOSED 36' MONOPINE TOWER.

CENTER OF TOWER:

LATITUDE: 35° 29' 14.310" NORTH (NAD83) LONGITUDE: 105° 54' 53.910" WEST (NAD83) GROUND ELEVATION @ 6705.4' NAVD88)

4. THE PERPENDICULAR DISTANCES FROM THE CENTER OF PROPOSED TOWER TO PARENT TRACT BOUNDARY LINE WERE ESTABLISHED FROM ACTUAL FIELD MEASUREMENTS AND OBSERVATIONS PERFORMED BY TERRAMARK LAND SURVEYING, DATED JUNE 6, 2018. AND ARE AS

218' 770' 886'

5. CONTRACTOR TO COORDINATE LOCATION OF POWER & TELCO DEMARCS WITH UTILITY PROVIDERS PRIOR TO BIDDING PROJECT.

BY GRAPHIC PLOTTING ONLY, THE SUBJECT PROPERTY
APPEARS TO LIE IN ZONE "X" OF THE FLOOD INSURANCE RATE MAP COMMUNITY PANEL NO. 40101C0095F, WHICH BEARS AN EFFECTIVE DATE OF FEBRUARY 04, 2011 AND IS NOT IN A SPECIAL FLOOD HAZARDL CHANCE FLOOD WITH AVERAGE DEPTHS OF LESS THAN 1 FOOT OR WITH DRAINAGE AREAS LESS THAN 1 SQUARE MILE; AND AREAS PROTECTED BY LEVEES FROM 1% ANNUAL CHANCE FLOOD AS DETERMINED BY THE FEDERAL EMERGENCY MANAGEMENT AGENCY UNDER THAT CIRCUMSTANCE.









SCALE VERIFICATION

BAR IS ONE INCH ON

ORIGINAL DRAWING. 1" IF NOT ONE INCH ON THIS SHEET, ADJUST SCALES ACCORDINGLY.

SCALE: 1"=200'

SITE ID: 1542 (2009392196)

NM4 LAMY

21 ASTRAL VALLEY RD LAMY, NM 87540

PROPOSED 36' MONOPINE

PROJECT NO: CHECKED BY: ISSUED FOR: REV DATE DRWN DESCRIPTION

> SCOTT VANCE Expires 12/31/2018

0 8/29/18 CAH ZONING SUBMITTAL




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OVERALL SITE PLAN

SHEET NUMBER:

REVISION

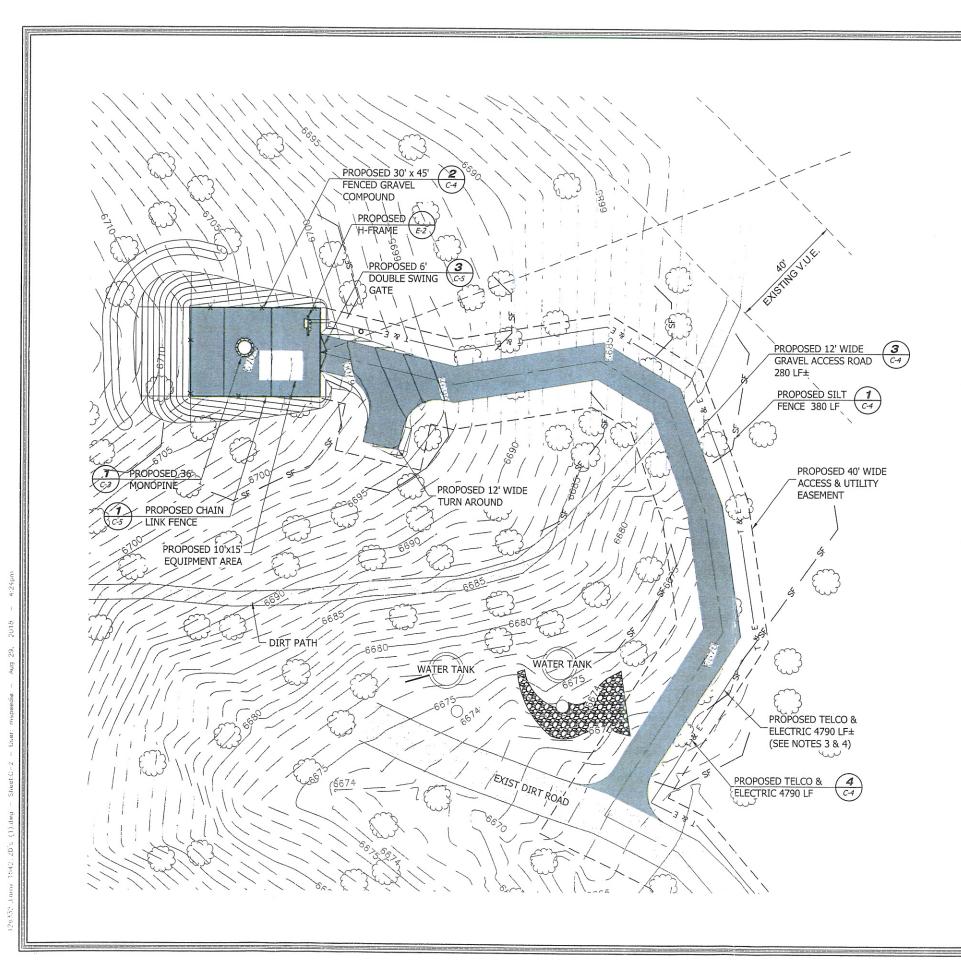

NOTES:

- 1. SEE LEGEND, ABBREVIATIONS & GENERAL NOTES ON SHEET GN-1.
- 2. EXISTING FEATURES SHOWN HEREON ARE BASED ON ACTUAL FIELD MEASUREMENTS AND OBSERVATIONS PERFORMED BY TERRAMARK LAND SURVEYING, DATED JUNE 6, 2018.
- 3. INSTALL 4790 LF± UNDERGROUND TELCO IN (1) 4" SCH. 40 PVC CONDUIT. INSTALL IN ACCORDANCE WITH OSHA AND ALL APPLICABLE CODES.
- 4. INSTALL 4790 LF± UNDERGROUND ELEC IN (1) 4" SCH. 40 PVC CONDUIT. INSTALL IN ACCORDANCE WITH OSHA AND ALL APPLICABLE CODES.
- 5. THE CONTRACTOR SHALL FIELD—VERIFY
 THE LOCATION OF ALL EXISTING ABOVE
 GROUND AND UNDERGROUND IMPROVEMENTS
 PRIOR TO COMMENCEMENT OF CONSTRUCTION.
- 6. THE CONTRACTOR SHALL BE RESPONSIBLE FOR ANY NECESSARY RELOCATION OR REPAIR OF EXISTING IMPROVEMENTS DUE TO DAMAGE CAUSED DURING CONSTRUCTION.
- 7. ALL SITE WORK SHALL BE CAREFULLY COORDINATED BY THE CONTRACTOR WITH LOCAL GAS, ELECTRIC, TELEPHONE AND ANY OTHER UTILITY COMPANIES HAVING JURISDICTION OVER THIS PROJECT.
- 8. CONTRACTOR SHALL COORDINATE POWER AND TELCO WITH WITH UTILITY PROVIDERS PRIOR TO BIDDING PROJECT.

THE CONTRACTOR SHALL VISIT THE SITE BEFORE BIDDING ON THE WORK CONTAINED WITHIN THIS DESIGN PACKAGE. DISCREPANCIES AND OMISSIONS SHALL BE BROUGHT TO THE ENGINEER'S ATTENTION PRIOR TO BIDDING.

LEG	END
3807	INDICATES EXISTING CONTOUR
SF	INDICATES PROPOSED SILT FENCE
FG=1154.1	INDICATES FINISHED GRADE ELEVATION









SCALE VERIFICATION

BAR IS ONE INCH ON

ORIGINAL DRAWING. 1"
IF NOT ONE INCH ON
THIS SHEET, ADJUST
SCALES ACCORDINGLY.

SCALE: 1"=15

SITE ID: 1542 (2009392196)

NM4 LAMY

21 ASTRAL VALLEY RD LAMY, NM 87540

PROPOSED 36' MONOPINE

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SCOTT VANCE 23682 Expires 12/31/2018



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PROPOSED IMPROVMENTS

REVISION:

SHEET NUMBER:

NAA -22

DIVERSION BERM

EXISTING GROUND



1. SEE LEGEND, ABBREVIATIONS & GENERAL NOTES ON SHEETS $\mbox{GN}-1$.

EXISTING FEATURES SHOWN HEREON ARE BASED ON ACTUAL FIELD MEASUREMENTS AND OBSERVATIONS PERFORMED BY TERRAMARK LAND SURVEYING, DATED JUNE 6, 2018.

- 2. THE CONTRACTOR SHALL FIELD—VERIFY THE LOCATION OF ALL EXISTING ABOVE GROUND AND UNDERGROUND IMPROVEMENTS PRIOR TO COMMENCEMENT OF CONSTRUCTION CONSTRUCTION.
- 3. THE CONTRACTOR SHALL BE RESPONSIBLE FOR ANY NECESSARY RELOCATION OR REPAIR OF EXISTING IMPROVEMENTS DUE TO DAMAGE CAUSED DURING
- 4. ALL SITE WORK SHALL BE CAREFULLY COORDINATED BY THE CONTRACTOR WITH LOCAL GAS, ELECTRIC, TELEPHONE AND ANY OTHER UTILITY COMPANIES HAVING JURISDICTION OVER THIS PROJECT.
- 6. CONTRACTOR TO VERIFY POSITIVE DRAINAGE. CONTACT ENGINEER IMMEDIATELY IF ANY DISCREPANCIES ARE FOUND.

THE CONTRACTOR SHALL VISIT THE SITE BEFORE BIDDING ON THE WORK CONTAINED WITHIN THIS DESIGN PACKAGE. DISCREPANCIES AND OMISSIONS SHALL BE BROUGHT TO THE ENGINEER'S ATTENTION PRIOR TO BIDDING.

LEGEND		
3807	INDICATES EXISTING CONTOUR	
SF	INDICATES PROPOSED SILT FENCE	
FG=1154.1	INDICATES FINISHED GRADE ELEVATION	





SCALE VERIFICATION

BAR IS ONE INCH ON ORIGINAL DRAWING.

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SCALE: 1"=10"

SITE ID: 1542 (2009392196)

NM4 LAMY

21 ASTRAL VALLEY RD LAMY, NM 87540

PROPOSED 36' MONOPINE

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ISSUED FOR:						
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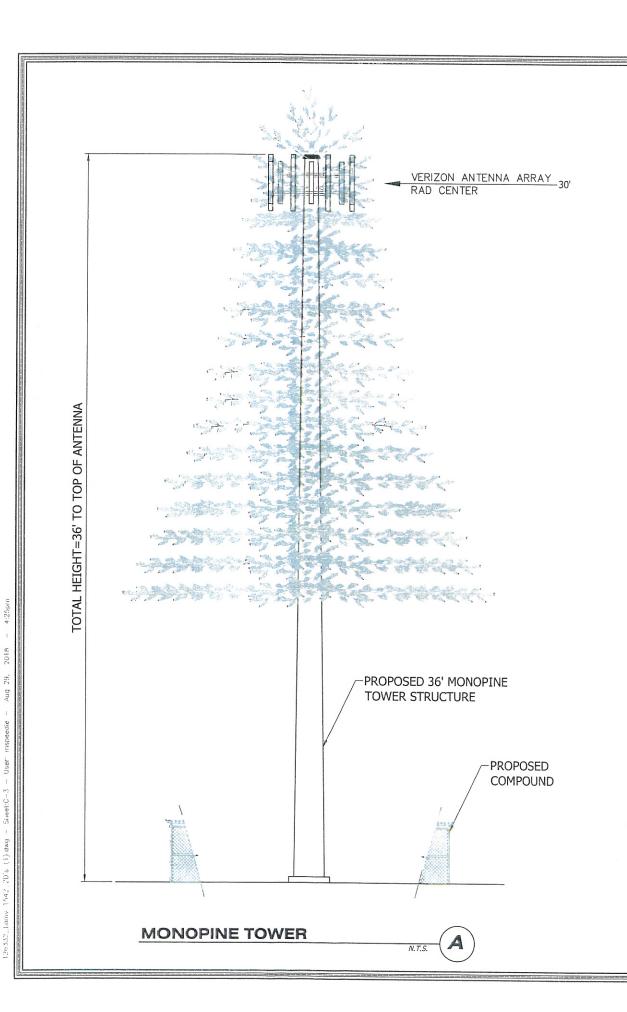
23682 Expires 12/31/2018



ENLARGED SITE PLAN








NOTES:

- 1. REFER TO STRUCTURAL PLANS BY OTHERS FOR TOWER SPECIFICATION & DETAILS.
- 2. THIS DETAIL IS FOR INFORMATION ONLY AND NOT FOR CONSTRUCTION PURPOSES.
- 3 NAVIGATIONAL HAZARD LIGHTING IS NOT REQUIRED IN ACCORDANCE WITH FAA REGULATIONS.
- 4. THE TOWER SHALL HAVE A BROWN PAINTED FINISH.
- 5. CARRIER RAD CENTER LINES SHALL BE VERIFIED WITH PI TELECOM INFRASTRUCTURE PRIOR TO COMMENCEMENT OF CONSTRUCTION.
- 6. ANTENNAS SHALL BE ENCLOSED, CAMOUFLAGED, SCREENED, OBSCURED OR OTHERWISE NOT READILY APPARENT TO A CASUAL OBSERVER.

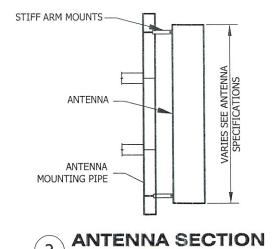



HEMPHILL'

SCALE VERIFICATION

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SCALE: N.T.S.

SITE ID: 1542 (2009392196)

NM4 LAMY

21 ASTRAL VALLEY RD LAMY, NM 87540

PROPOSED 36' MONOPINE

PROJECT NO: CHECKED BY: ISSUED FOR:
 REV
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> SCOTT VANCE 23682 Expires 12/31/2018



TOWER **ELEVATION**



SITE ADDRESS: 99 ASTRAL VALLEY RD. **SANTA FE COUNTY 87540 NEW MEXICO**


COORDINATES: LAT: 35°29'14.310"N LONG: 105°54'53.910"W

CONTENTS:

- 1: COVER
- EXISTING NORTHWEST ELEVATION
- NORTHWEST ELEVATION SIMULATION EXISTING NORTHEAST ELEVATION NORTHEAST ELEVATION SIMULATION
- EXISTING SOUTH ELEVATION
- 7: SOUTH ELEVATION SIMULATION



NM4 LAMY SITE PHOTO **EXISTING NORTHWEST ELEVATION** JANUARY 20, 2016

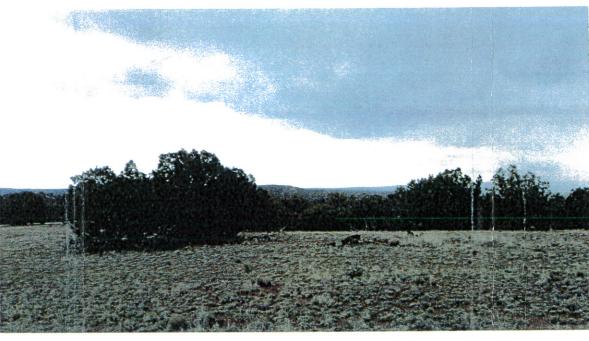



NM4 LAMY SITE PHOTO NORTHWEST ELEVATION SIMULATION JANUARY 20, 2016



NM4 LAMY SITE PHOTO EXISTING EAST ELEVATION JANUARY 20, 2016





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SCALE: N.T.S.

SITE ID: 1542 (2009392196)

NM4 LAMY

21 ASTRAL VALLEY RD LAMY, NM 87540

PROPOSED 36 MONOPINE

PROJECT NO: 126332 CHECKED BY: MAS ISSUED FOR: REV DATE DRWN DESCRIPTION 0 8/29/18 CAH ZONING SUBMITTAL

SCOTT VANCE 23682 Expires 12/31/2018



PHOTO SIMULATION



NM4 LAMY SITE PHOTO EAST ELEVATION SIMULATION JANUARY 20, 2016



NM4 LAMY SITE PHOTO EXISTING SOUTH ELEVATION JANUARY 20, 2016



NM4 LAMY SITE PHOTO SOUTH ELEVATION SIMULATION JANUARY 20, 2016





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SCALE: N.T.S.

SITE ID: 1542 (2009392196)

NM4 LAMY

21 ASTRAL VALLEY RD LAMY, NM 87540

PROPOSED 36' MONOPINE

	PROJECT NO:			126332	
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SCOTT VANCE 23682 Expires 12/31/2018



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PHOTO SIMULATION